

## Frankston City Council

ABN: 49 454 768 065

30 Davey Street, Frankston, Victoria, Australia Telephone: 1300 322 322 » +613 9784 1888 » Facsimile: +613 9784 1094 PO Box 490, Frankston VIC 3199 info@frankston.vic.gov.au Website: frankston.vic.gov.au

Application Number 156/2024/LP

Michelle Thompson

Telephone 1300 322 322

**Customer Reference** 

22 May 2024

**Enquiries** 

Creative House Plans 48 Bona Vista Rise CLYDE NORTH VIC 3978

Application No 156/2024/LP

Address 17 Railway Parade, Seaford

Lot/Plan Lot 1 LP 47803

As requested, please find attached the location of your stormwater discharge point which is to the new pit which is to be constructed via outfall drain and to be connect to existing pit within the laneway as per the Approved drainage plans dated 28 October 2021, Project No. 2014OM, Sheet No's C01-05, Revision 02 & 03.

Council provides stormwater point of discharge to accommodate a single dwelling with of no more than 40% site coverage. It is advised that development of this site with a greater site coverage than 40% will require the provision of a Stormwater Detention System with a volume capable of retarding the 10-year ARI flow from the development site back to a 5-year ARI pre-development value. Water Sensitive Urban Design principles (WSUD) can be incorporated into the drainage design to reduce the site outflow to the required 5-year ARI pre-development value.


Where a site is subject to a Planning Permit for development, the discharge location may be subject to alteration. All Planning Permit conditions must be complied with to the satisfaction of the Engineering Services Manager

If you have further questions, please contact Michelle Thompson from the Engineering Services department on 1300 322 322

Kind regards,

Michelle Thompson
TECHNICAL SUPPORT OFFICER
ENGINEERING SERVICES

## 17 Railway Parade, Seaford

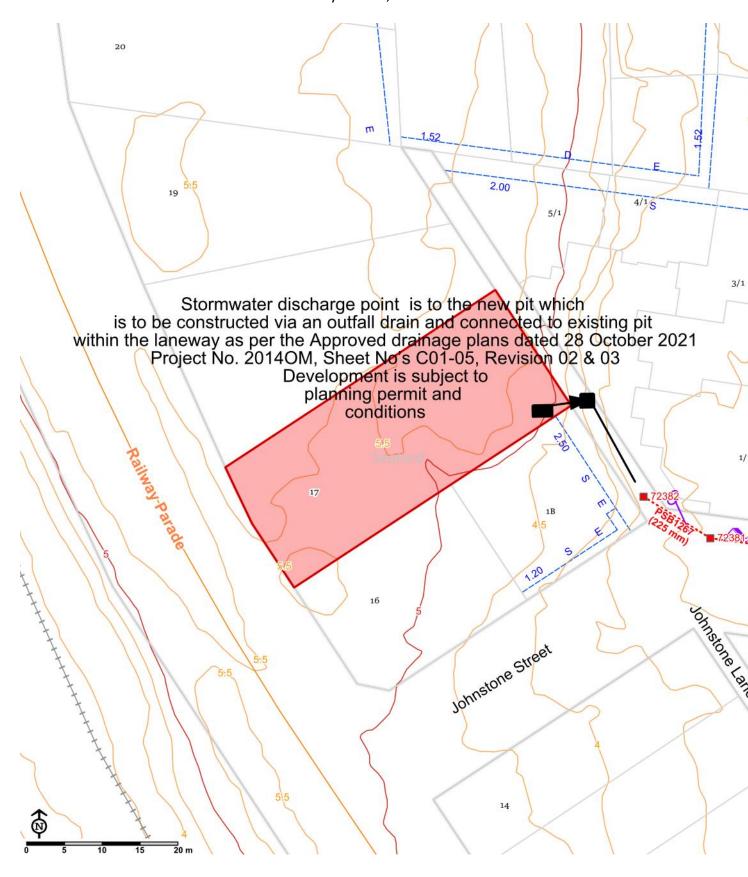

## Disclaimer

Contains Council information © Frankston City Council, 2024. Reproduced by permission of the Information Services Department, Frankston City Council. Contains Vicmap information © State of Victoria, Department of Environment and Primary Industry, 2024. Reproduced by permission of the Department of Environment and Primary Industry. This material may be of assistance to you but Frankston City Council, the State of Victoria and their employees do not guarantee that the publication is without flaw of any kind or is wholly appropriate for your particular purposes and therefore disclaim all liability for any error, loss or consequences which may arise from your relying on any information contained in this material. You are hereby notified that any use, dissemination, distribution or reproduction of this information is prohibited and must be used for personal use only. The information contained herein must not be used in any manner that could breach any criminal, federal, state or local law.

Projection: # GDA94 / MGA zone

\_ . . . \_ .

Scale: 1:500

Date Printed: 22/05/2024


Time Printed: 12:51 PM


Issued by: Thompson


12:51 PM Michelle





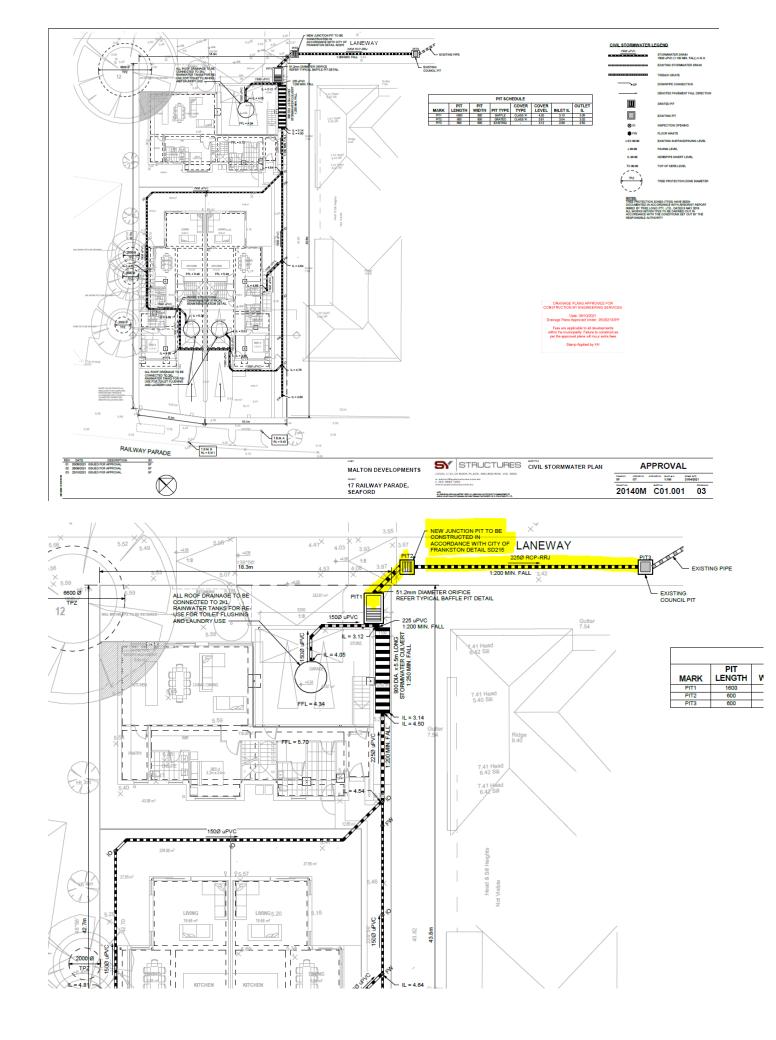

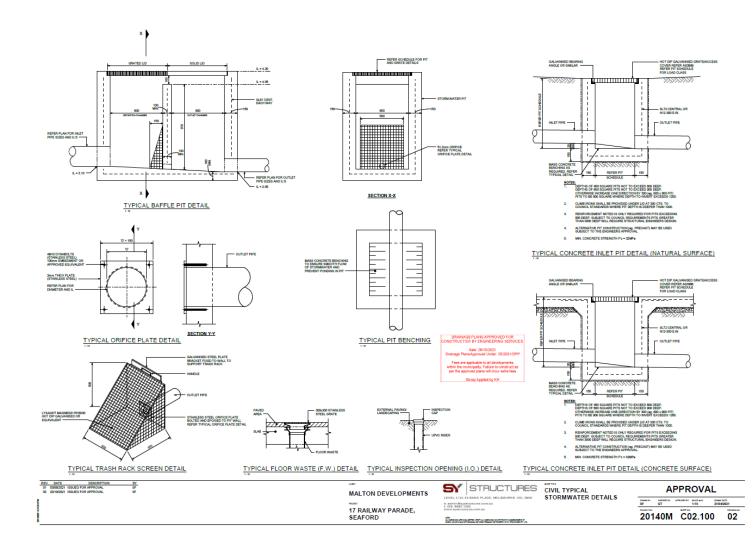


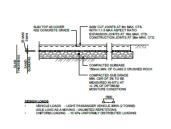




Shin WIDE SAW OUT, TIS DEEP OUT WITHIN 16 HOURS OF POUR FINISH WITH TYP, JOINT FILLER DETAIL

TYPICAL CONSTRUCTION JOINT (C.J.) DETAIL (PAVING) TYPICAL SAWCUT (S.C.) DETAIL (PAVING)

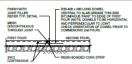

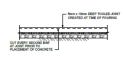



LIGHT DUTY TRAFFICABLE EXTERNAL PAVING SLAB DETAIL

PAVING SLAB FINISH TO LANDSCAPE ARCHITECTS DETCH SMR


NON TRAFFICABLE EXTERNAL PAVING SLAB WITH APPLIED FINISH

SL62 MESH, 30 TOP CON N32 CONCRETE GRADE

TYPICAL EXPANSION JOINT (E.J.) DETAIL (PAVING)

TYPICAL TOOLED JOINT (T.J.) DETAIL (PAVING)

TYPICAL JOINT FILLER DETAIL (PAVING)

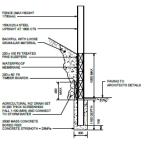

TYPICAL TIMBER SLEEPER RETAINING WALL DETAIL

1-39

FOR 4508 BORID PIERS, BORID PIER BETH TO BE SCHEARAGED BY 20%
IN ARABY SOULS BORD PIER BETH TO BE INCIDENCE BY 10%.

Date: 28/10/2021 Drainage Plans Approved Under: 25/2021/DPF

SUBBASE AND SUBGRADE DESIGN CRITERIA:

COMPACT SUBGRADE TO DES OF STANDARD AT 2 YE OF OPTIMUM MOISTURE CONTENT. TO DES OF STANDARD AT 2 YE OF OPTIMUM OF MOISTURE CONTENT. TO DES OF STANDARD AT 2 YE OF OPTIMUM OF MOISTURE CONTENT. COMPACT IN LAYERS OF 150 MAXIMUM LOGIC MATERIA. MATERIAL.

COMPACT SUB BASE MATERIAL TO 98% OF STANDARD AT 1 2% OF OPTIMUM MOSTURE CONTENT. COMPACT IN LAYERS OF 150 MAXIMUM LOOSE MATERIAL.

 
 REV.
 DATE
 DESCRIPTION
 BY

 01
 03/05/2021
 ISSUED FOR APPROVAL
 SF


 02
 22/19/2021
 ISSUED FOR APPROVAL
 SF
 MALTON DEVELOPMENTS

e. admin Enystructures can t. (03) 8692 7262 vawe systructures com au 17 RAILWAY PARADE, SEAFORD CONTROL OF A SECURITY OF THE SECURITY OF T


SY STRUCTURES CIVIL TYPICAL CONCRETE PAVING SLAB DETAILS

GT 12,120, 2194202 20140M C02.200 02

APPROVAL

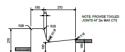



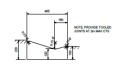







TYPICAL KERB AND GUTTER (KG)

TYPICAL BARRIER KERB AND GUTTER (BK)

TYPICAL MODIFIED LAYBACK KERB (MLBK)


TYPICAL MOUNTABLE KERB (MK) DETAIL

TYPICAL KERB ONLY (KO)


TYPICAL BARRIER KERB (BK)






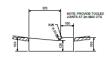

TYPICAL ROAD/PAVING TO KERB AND GUTTER DETAIL

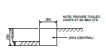

TYPICAL EDGE STRIP (ES)

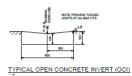

	REV. DATE DESCRIPTION 01 03/05/2021 ISSUED FOR APPROVAL	BY CONTRACTOR OF THE CONTRACTO	SINT	CTD ICT IDEC	PRETTA	***************************************	
ž	02 22/10/2021 ISSUED FOR APPROVAL	er er	MALTON DEVELOPMENTS		CIVIL TYPICAL KERB DETAILS	APPROVAL	
				LEVEL 1/11-19 BANK PLACE, MELBOURNE, VIC. 3000		SE GT PROSESS AMORDS EAST-AN	21/04/2021
*				t. (03) 8692 7262		SF GT 1:10	21/04/2021
ã			17 RAILWAY PARADE,			20140M C02.400 02	
ñ			SEAFORD	CT SERVICES ARE WAS INTO CHAPMAS, DEPOCAÇÃO CHAPMAS TO COMMISSION OF THE COMMISSION		20140W C02.400 02	