BUILDING RULES CONSENT GRANTED SUBJECT TO CONSENT GRANTED SUBJECT TO CONDITIONS I CONSENT COUNTING CONTRACTOR CONTRACTOR

LOT 48 LIBERATOR WAY, WALLAROO SHORES

S.A. 5556





3D VIEW 1



	AN	IENDMENTS	
Rev	Date	Description	Drawr
Α	14.03.23	PLANNING ISSUE	C.I.
В	24.03.23	DEKTON BLADE WALL	C.I.
С	24.04.23	ENCUMBRANCE RFI	C.I.
D	19.06.23	COUNCIL RFI	C.I.
Е	31.07.23	CONSULTANT ISSUE	C.I.
F	21.11.23	MINOR CHANGES	C.I.
G	31.01.24	CERTIFIER ISSUE	C.I.
Н	14.02.24	CERTIFIER RFI	C.I.
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AT:	ROPOSE EVELOP OT 48 LI	ED RESIDENTIAL MENT BERATOR WAY, DO SHORES	
CLIEN	M. & D	. KALLIOS	
CI		MARCH 2	2023
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PROJ	ECT No.	SHEET N	0.
16.2	2023	PA 01 OF	24
MAKII SHAL AND	LS ON SITE B NG SHOP DR. L TAKE PREF	RE TO VERIFY ALL DIMENSION DEFORE COMMENCING ANY WAWINGS. FIGURED DIMENSION DEFERENCE OVER SCALED DIME PANCY SHALL BE REPORTED DIATELY	ORK OR NS NSIONS

GENERAL NOTES

PROPOSED BUILDING IS TO BE CONSTRUCTED OF HEBEL VENEER CONSTRUCTION COMPRISING OF 75mm THK. HEBEL POWER PANEL, 25mm CAVITY AND 90mm TIMBER STUD WALL TO GROUND AND UPPER LEVEL; BOTH LEVELS LINED WITH 10mm PLASTERBOARD WALL LINING. VILLABOARD TO WET AREAS.

ALL EXPOSED TIMBER MEMBERS AND FIXINGS ARE TO BE ADEQUATELY TREATED WITH PRESERVATIVE IN ACCORDANCE WITH AS 1604

VERIFY ALL FINISHED LEVELS BEFORE THE COMMENCEMENT OF ANY BUILDING WORK.

TERMITE PROTECTION SHALL COMPLY WITH AS3660.1, PROVIDE CERTIFICATE IN ACCORDANCE WITH AS3660.1STATING METHOD OF APPLICATION AND CERTIFICATE OF COMPLETION

ROOF CONTRACTOR SHALL PROVIDE ALL NECESSARY FLASHINGS, CAPPINGS AND OTHER ITEMS REQUIRED TO MAKE THE ROOF WATERTIGHT AND COMPLETE.

BUILDER TO CHECK AND CONFIRM ALL SITE AND SET OUT DIMENSIONS PRIOR TO COMMENCEMENT OF CONSTRUCTION

ALL GLAZING TO COMPLY WITH AS ALL GLAZING IS TO BE SUPPLIED AND INSTALLED IN ACCORDANCE WITH AS

ALL SANITARY, PLUMBING, DRAINAGE & ELECTRICAL WORK TO BE CARRIED OUT BY FULLY QUALIFIED AND LICENSED TRADESPERSONS.

ALL ELECTRICAL WORK CARRIED OUT, TO BE IN ACCORDANCE WITH AS 3000.


THIS DRAWING IS TO BE READ IN CONJUNCTION WITH ALL OTHER DRAWINGS, DOCUMENTS, SCHEDULES AND SPECIFICATIONS

ALL STEEL WORK TO COMPLY WITH BCE.C & C.GART 3.4.2.

WATERPROOFING OF WET AREAS WILL BE IN ACCORDANCE WITH AS3740-2021 & 10.2.12 OR PART 10.2.7 TO 10.2.32 OF ABCB HOUSING PROVISIONS (INCLUDING SA 10.2.1 AND SA 10.2.33)





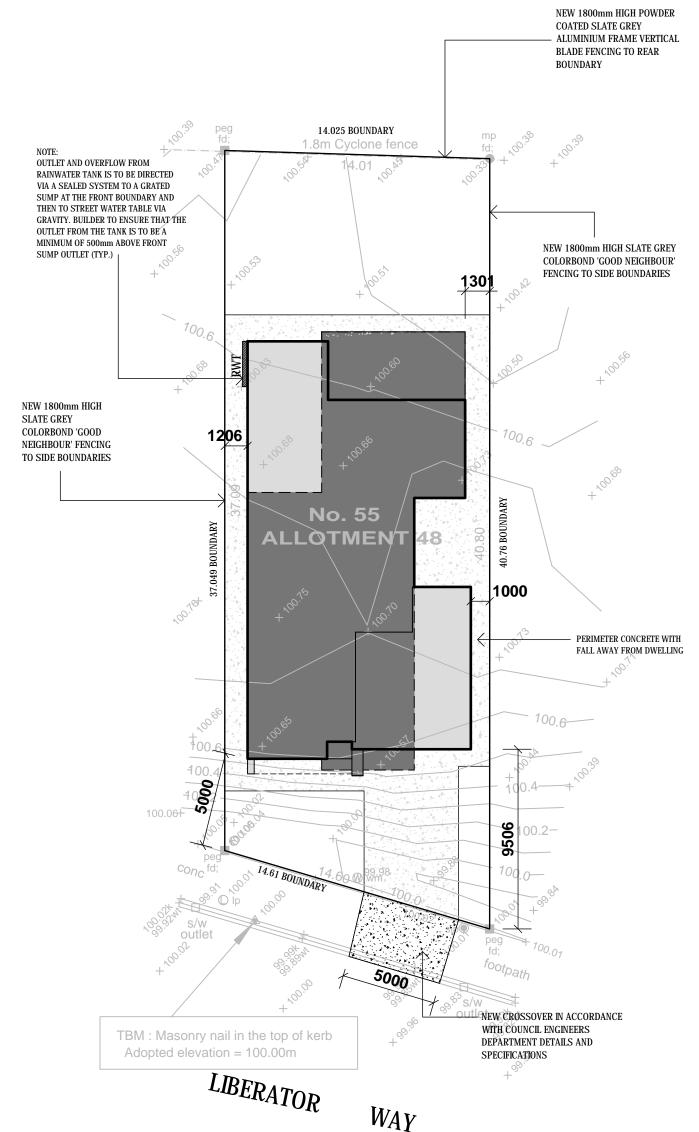

SITE PLAN

STORMWATER TO BE IN ACCORDANCE WITH ENGINEERS DETAILS & RECOMMENDATIONS AND DIRECTED TO STREET WATER TABLE IN 90MM Ø PVC STORMWATER PIPE

SITE STORMWATER DRAINAGE WILL BE CONSTRUCTED IN ACCORDANCE WITH AS/NZS 3500.3 – 2018 INCLUDING: • PROVIDE SUMPS WITH OVERFLOWS TO FRONT BOX GUTTERS



AREAS: LOWER LIVING 172.23 **UPPER LIVING** 165.18

FOR CERTIFICATION ONLY

GARAGES 45.28 **BALCONY** 27.32 **ALFRESCO** 26.27 **PORCH** 1.17 **TOTAL** 437.45 SQ.M. 545.30 SQ.M. SITE 203.91 SQ.M. **POS**

44.92 % SITE COVER SOFT L.SCAPE 30.64 % **AMENDMENTS**

Rev Date Description
A 14.03.23 PLANNING ISSUE B 24.03.23 DEKTON BLADE WALL C.I. C 24.04.23 ENCUMBRANCE RFI C.I. D 19.06.23 COUNCIL RFI C.I. E 31.07.23 CONSULTANT ISSUE F 21.11.23 MINOR CHANGES G 31.01.24 CERTIFIER ISSUE H 14.02.24 CERTIFIER RFI



SUITE 1 / 159 PORT ROAD HINDMARSH SA 5007 T: 8338 2211 F: 83382188

PROPOSED RESIDENTIAL DEVELOPMENT LOT 48 LIBERATOR WAY, WALLAROO SHORES

M. & D. KALLIOS

CI


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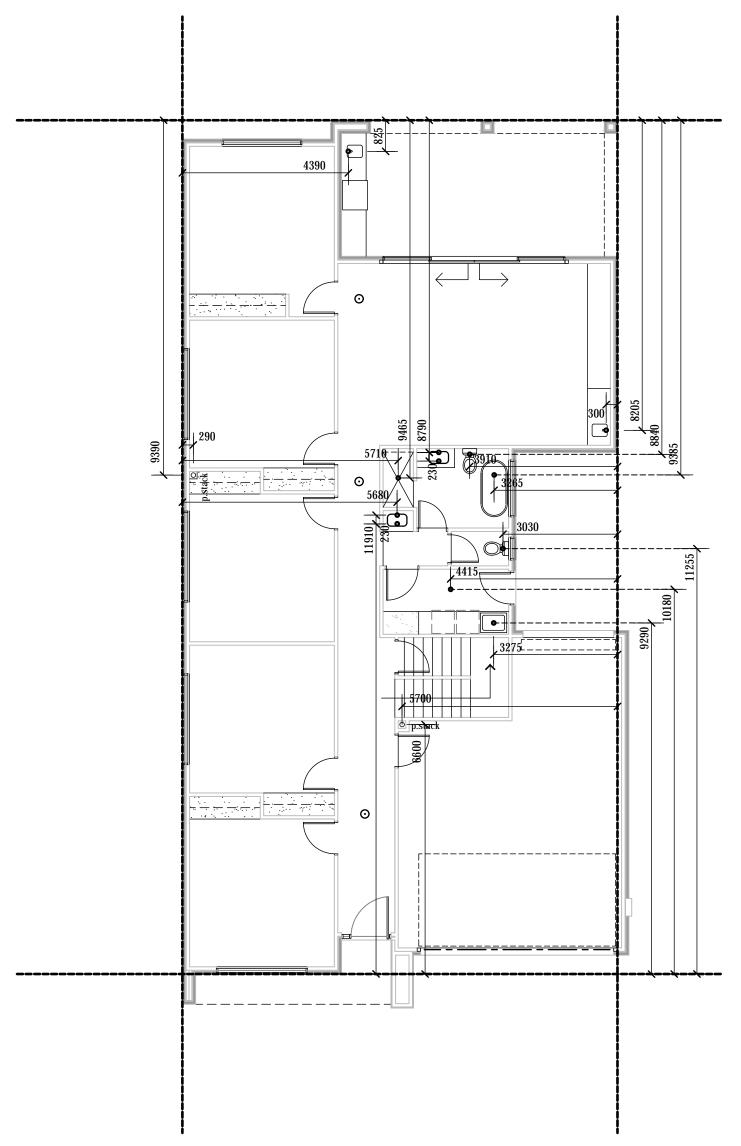
LOT 48 LIBERATOR WAY, WALLAROO SHORES

M. & D. KALLIOS

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PROJECT No.	SHEET No.
16.2023	WD 03 OF 24





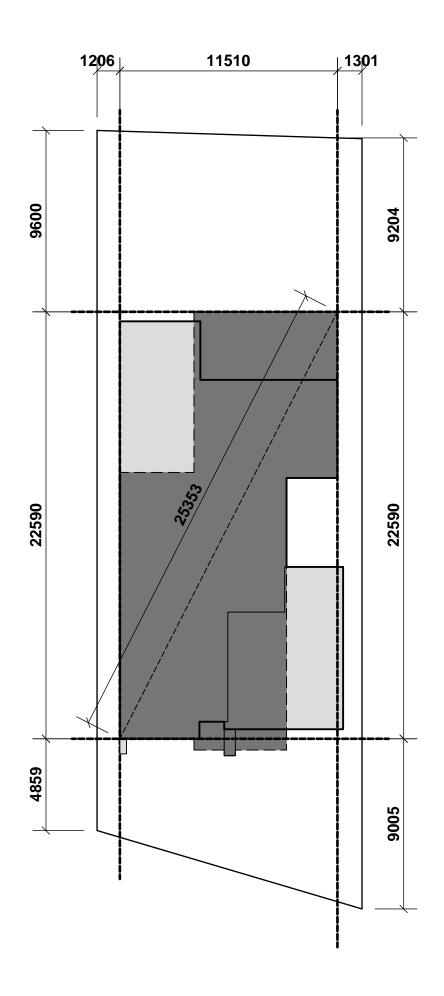

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S U I T E 1 / 159 P O R T R O A D H I N D M A R S H S A 5007 T: 8338 2211 F: 83382188

PROPOSED RESIDENTIAL
DEVELOPMENT
LOT 48 LIBERATOR WAY,
WALLAROO SHORES

CLIENT

M. & D. KALLIOS


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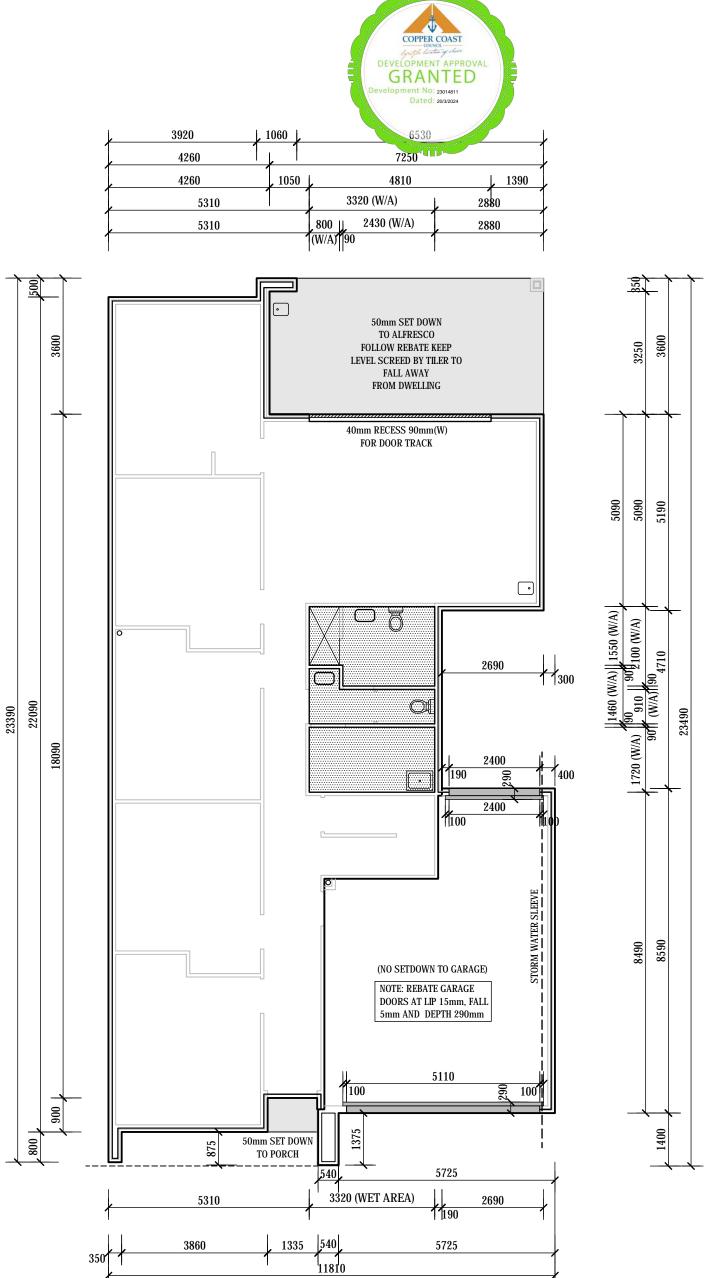
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PROJECT
PROPOSED RESIDENTIAL
DEVELOPMENT
AT: LOT 48 LIBERATOR WAY,
WALLAROO SHORES

CLIENT

M. & D. KALLIOS



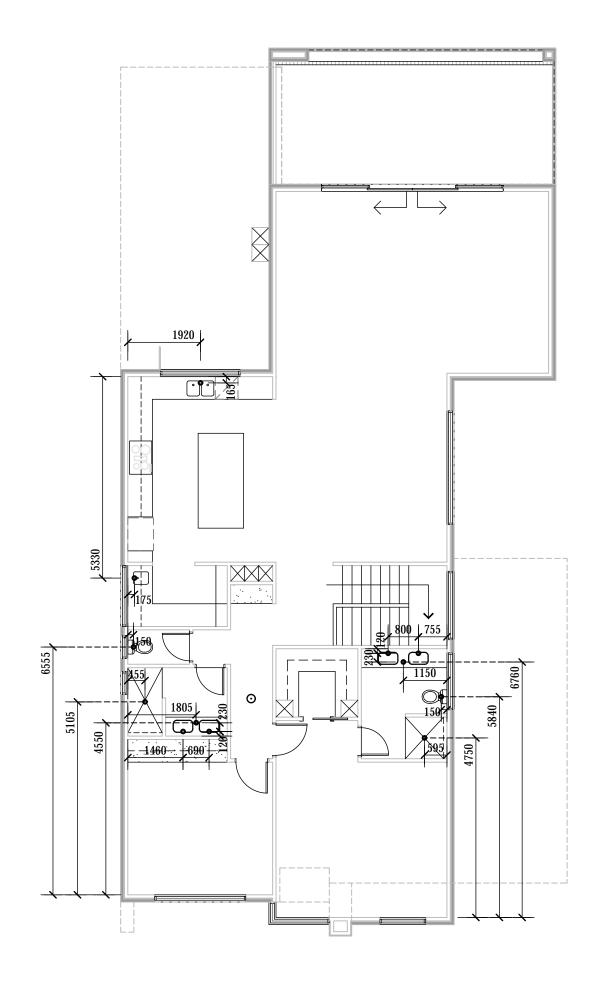

CONCRETE PLAN

SCALE 1:100

REINFORCED CONCRETE FOOTING AND SLAB SYSTEM AS PER ENGINEERS DESIGN AND DETAILS.

TERMITE NOTE:

TERMITE RISK MANAGEMENT IS TO COMPLY WITH PART 3.1.4 BCA 2019 WHERE THE CONCRETE SLAB ON GROUND OF A TERMITE BARRIER IS TO BE AS PART SYSTEM, THE SLAB MUST BE DESIGNED & CONSTRUCTED TO COMPLY WITH AS 2870-2011

SLABS MUST HAVE PENETRATIONS, CONTROL JOINTS AND THE PERIMETER PROTECTED

THE SLAB ON GROUND MAY BE USED AS PERIMETER PROTECTION PROVIDED THAT THE SLAB IS EXPOSED 75 mm ABOVE FINISHED GROUND LEVEL AND THE SLAB EDGE DOES NOT HONEYCOMBED, ROUGH OR CONTAIN RIPPLES

CHEMICAL TERMITICIDE TO UNDERSIDE OF CONCRETE SLAB IN ACCORDANCE WITH AS 3660.1-2014 (BIFLEX OR SIMILAR)

OR STAINLESS STEEL MESH BARRIER EITHER FULL OR PARTIAL PROTECTION TERMIMESH

OR SIMILAR)
OR GRADED STONE BARRIER
OR KORDON TERMITE BARRIER

NOTE: BUILDER TO SELECT IN CONSULTATION WITH OWNER

CONCRETOR'S NOTE:

ALLOW FOR SUB-FLOOR STORMWATER PIPES PRIOR TO POURING OF SLAB.

86mm EDGE REBATE TO PERIMETER OF HOUSE.

FOOTING EDGE IS TO BE EXPOSED A MINIMUM OF 75mm ABOVE PAVING LEVEL OR ALTERNATIVE PERIMETER TERMITE TREATMENT IS REQUIRED.

ALLOW FOR POWER CONDUIT TO DISHWASHER IN ISLAND BENCH

WET AREA NOTES:

SET DOWN WET AREAS 45mm. SCREED WITH REQUIRED FALL TO FLOOR TRAP

THE FLOOR OF A WET AREA CONTAINING A VESSEL MUST BE GRADED TO FLOOR WASTE UNLESS ALL VESSELS ARE PROVIDED WITH IN-BUILT OVERFLOW PROTECTION OR HAVE PERMANENT OPEN TRAPPED CONNECTION TO THE PLUMBING IN ACCORDANCE WITH SA 10.2.33.

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 SUITE 1 / 159 PORT ROAD

 HIND MARSH SA 5007

 T: 8338 2211

 F: 83382188

PROPOSED RESIDENTIAL
DEVELOPMENT

LOT 48 LIBERATOR WAY,
WALLAROO SHORES

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16.2023	WD 06 OF 24


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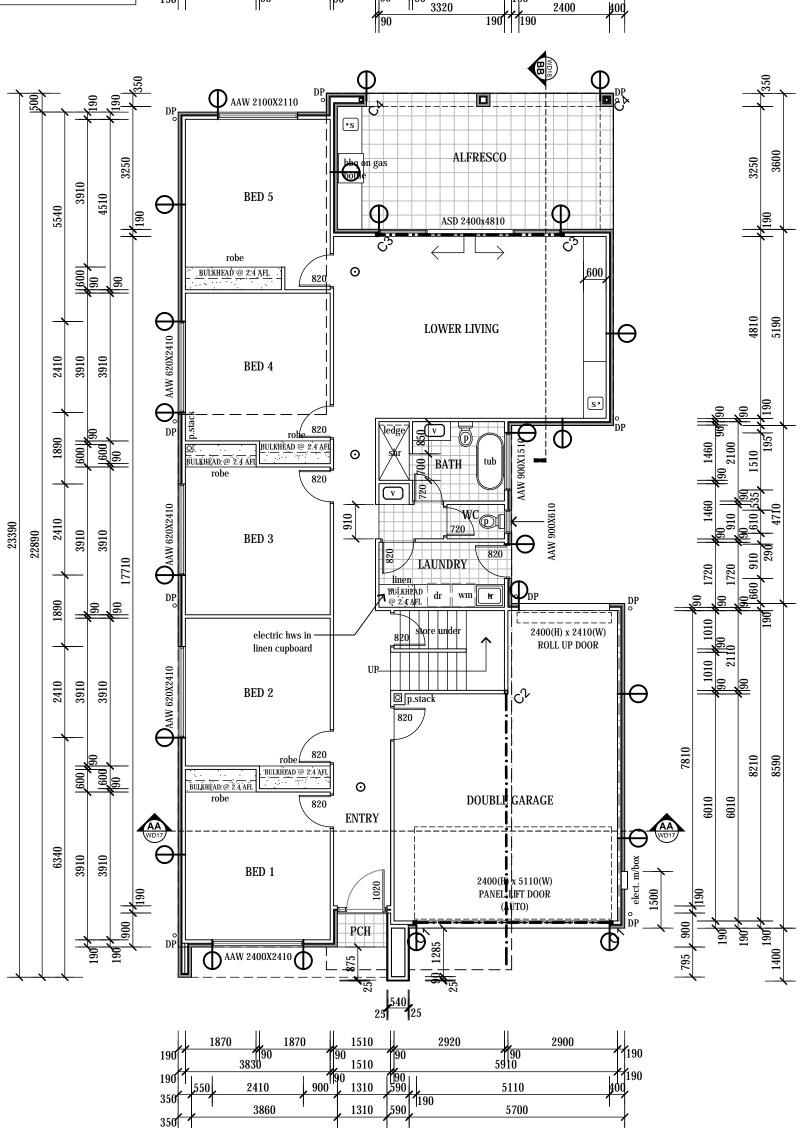


BUILDING RULES CONSENT SER DENFELOPMENT IS

STRUCTURAL STEEL IS TO BE PROVIDED WITH A PROTECTIVE COATING IN ACCORDANCE WITH TABLE 6 3 9A 6 3 9B & 6.9.3C OF THE ABCB HOUSING PROVISIONS

METAL ROOF SHEETING IS TO BE PROVIDED WITH A METAL COATING IN ACCORDANCE WITH TABLE 7.2.2A OF THE ABCB HOUSING PROVISIONS



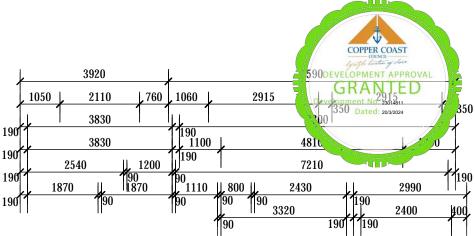

11810

FIRE APPLIANCE WILL BE GAS OR IF A COMBUSTION HEATER IT WILL BE INSTALLED IN ACCORDANCE WITH

ANY SARKING TYPE MATERIALS USED IN THE ROOF IS TO ACHIEVE A FLAMMABILITY INDEX NOT GREATER

PROVISIONS FOR THE MANAGEMENT OF RISKS ASSOCIATED WITH WATER VAPOUR AND CONDENSATION:

FXHAUST IN KITCHEN, BATHROOM, SANITARY COMPARTMENT OR LAUNDRY MUST ACHIEVE FLOW

RATES OF -- 25L/S FOR BATHROOM OR SANITARY COMPARTMENT; AND

- 40L/S FOR KITCHEN & LDRY. - EXHAUST DIRECTLY VIA SHAFT OR DUCT TO ATMOSPHERE **ENERGY RATING NOTES**

REFER TO ENERGY RATING REPORT FOR INSULATION DETAILS AND LOCATIONS

FXTERNAL SWING DOORS TO BE FITTED WITH DRAUGHT PROTECTION DEVICE TO BOTTOM EDGE OF EACH LEAF.

HOT WATER SUPPLY SYSTEM DESIGNED AND INSTALLED IN ACCORDANCE WITH SECTION 6A OF AS/NZS 3500.4.2 OR CLAUSE 3.38 OF AS/NZS 3500.5

GLAZING TO WINDOWS AND GLAZED DOORS AS PER ENERGY REPORT.

AS 1288 PROVIDE 5mm TOUGHENED GLASS TO ALL SLIDING DOORS AND WINDOW ABOVE BATH WITH 3mm FLOAT GLASS TO REMAINDER

ODENOTES SMOKE DETECTOR HARD WIRED IN ACCORDANCE WITH AS 3786 SMOKE ALARMS TO BE INTERCONNECTED AS PER BCA PART 3.7.5.2(d) BCA-P2.3.2

PDENOTES VERTICAL CONTROL JOINTS IN ACCORDANCE WITH ENGINEERS DETAILS.

W.C. DOOR TO BE FASILY REMOVABLE FROM OUTSIDE OF THE COMPARTMEN

AREAS:

LOWER LIVING 172.23 **UPPER LIVING** 165.18 **GARAGES** 45.28 **BALCONY** 27.32 **ALFRESCO** 26.27 **PORCH** 1.17 **TOTAL** 437.45 SQ.M. SITE 545.30 SQ.M. 203.91 SQ.M. POS 44.92 % SITE COVER SOFT L.SCAPE 30.64 %

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SUITE 1 / 159 PORT ROAD HINDMARSH SA 5007 T: 8338 2211 F: 83382188

PROPOSED RESIDENTIAL DEVELOPMENT LOT 48 LIBERATOR WAY, WALLAROO SHORES

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M. & D. KALLIOS

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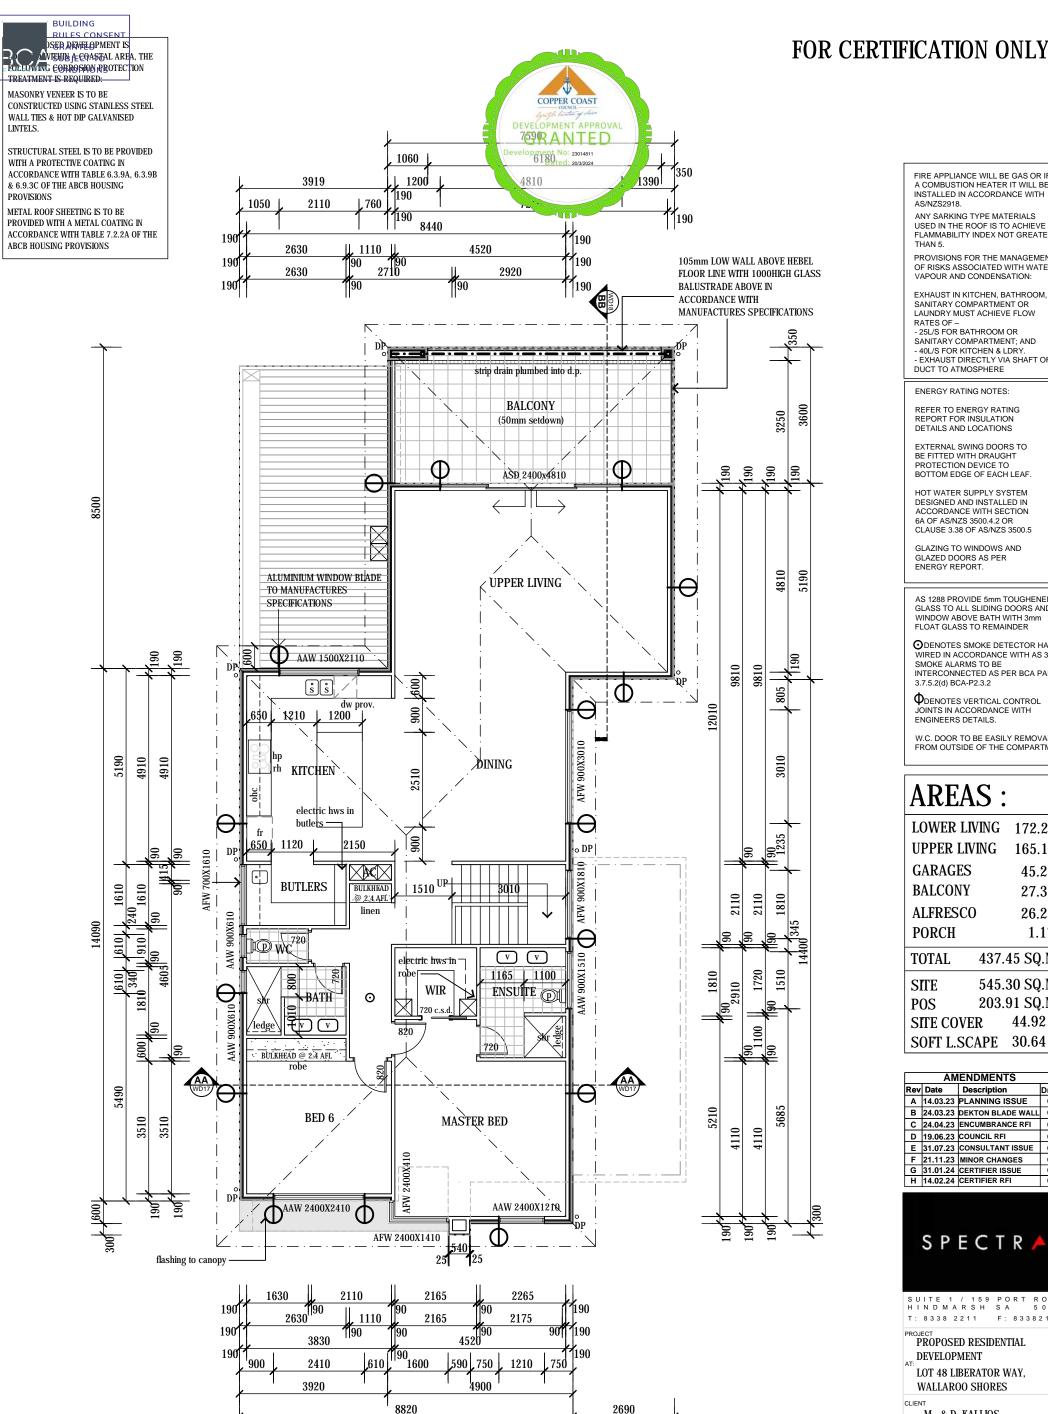
DATE

CONTRACTORS ARE TO VERIFY ALL DIMENSIONS AND LEVELS ON SITE BEFORE COMMENCING ANY WORK OR MAKING SHOOP DRAWINGS, FIGURED DIMENSIONS SHALL TAKE PREFERENCE OVER SCALED DIMENSIONS AND ANY DISCREPANCY SHALL BE REPORTED TO THE DESIGNERS IMMEDIATELY

LOWER FLOOR PLAN

SCALE 1:100 (HEBEL POWERPANEL CONSTRUCTION) WATERPROOFING OF WET AREAS WILL BE IN ACCORDANCE WITH AS3740-2021 & 10.2.12 OR PART 10.2.7 TO 10.2.32 OF ABCB HOUSING PROVISIONS

(INCLUDING SA 10.2.1 AND SA 10.2.33)



WATERPROOFING OF WET AREAS WILL BE IN ACCORDANCE WITH AS3740-2021 & 10.2.12 OR PART 10.2.7 TO 10.2.32 OF ABCB HOUSING PROVISIONS (INCLUDING SA 10.2.1 AND SA 10.2.33)

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PROVISIONS FOR THE MANAGEMENT OF RISKS ASSOCIATED WITH WATER VAPOUR AND CONDENSATION:

FXHAUST IN KITCHEN, BATHROOM, SANITARY COMPARTMENT OR LAUNDRY MUST ACHIEVE FLOW

RATES OF -- 25L/S FOR BATHROOM OR SANITARY COMPARTMENT; AND - 40L/S FOR KITCHEN & LDRY. - EXHAUST DIRECTLY VIA SHAFT OR DUCT TO ATMOSPHERE

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REFER TO ENERGY RATING REPORT FOR INSULATION DETAILS AND LOCATIONS

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GLAZING TO WINDOWS AND GLAZED DOORS AS PER ENERGY REPORT.

AS 1288 PROVIDE 5mm TOUGHENED GLASS TO ALL SLIDING DOORS AND WINDOW ABOVE BATH WITH 3mm FLOAT GLASS TO REMAINDER

ODENOTES SMOKE DETECTOR HARD WIRED IN ACCORDANCE WITH AS 3786 SMOKE ALARMS TO BE INTERCONNECTED AS PER BCA PART 3.7.5.2(d) BCA-P2.3.2

PDENOTES VERTICAL CONTROL JOINTS IN ACCORDANCE WITH ENGINEERS DETAILS.

W.C. DOOR TO BE EASILY REMOVABLE FROM OUTSIDE OF THE COMPARTMEN

AREAS:

SITE COVER

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SOFT L.SCAPE 30.64 %



SUITE 1 / 159 PORT ROAD HINDMARSH SA 5007 T: 8338 2211 F: 83382188

PROPOSED RESIDENTIAL DEVELOPMENT LOT 48 LIBERATOR WAY, WALLAROO SHORES

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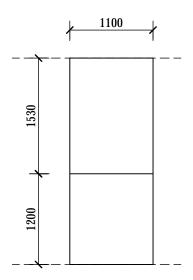
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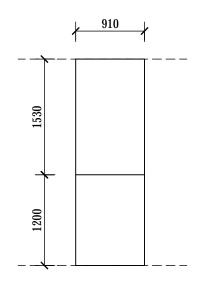







UPPER LEVEL
ENSUITE SHR LEDGE DETAIL

SCALE 1:50



UPPER LEVEL BATH SHR LEDGE DETAIL


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LOWER LEVEL BATH SHR LEDGE DETAIL

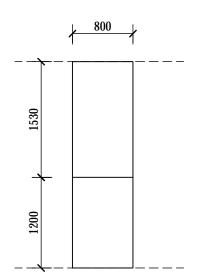
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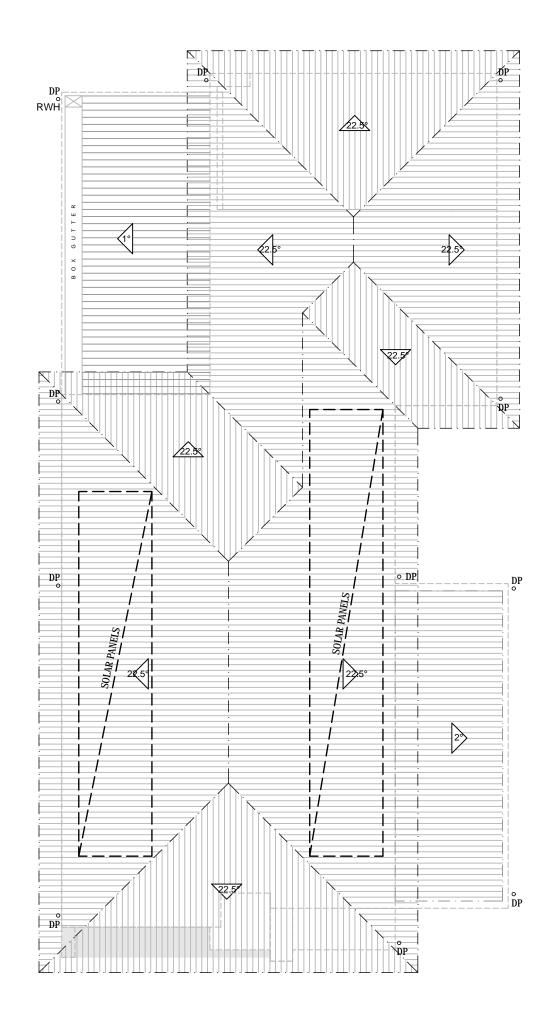
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BUILDING **RULES CONSENT** GUATTERS WILL BE PROVIDED WITH CONTINUOUS BOW PROVISIONS IN ACCORDANCE WITH BCA-TABLE 7.4.4A AND BOX CONTERS WITH DEDICATED OVERFLOW PROVISIONS IN ACCORDANCE WITH BCA-TABLE 7.4.4B OR PROVIDE DETAILS OF THE OVERFLOW PROVISIONS TO THE DOWNPIPE AND GUTTER SYSTEM IN ACCORDANCE WITH CLAUSE 7.4.4 (REFER BELOW)

FOR CERTIFICATION ONLY



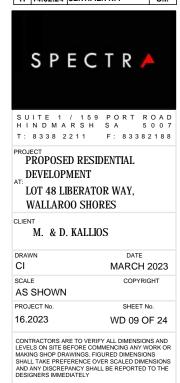

NOTES

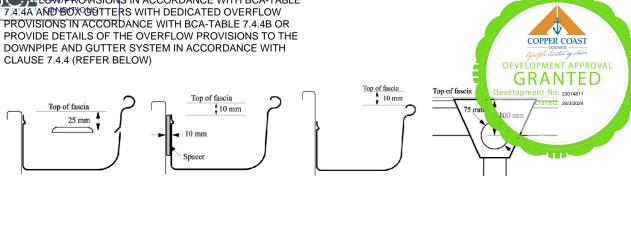PROVIDE FLASHINGS, SEAL AND ADEQUATELY FLASH ALL PENETRATIONS, JUNCTIONS AND JOINTS. INSTALL ROOF DECK, FLASHINGS AND FITTINGS IN ACCORDANCE WITH THE MANUFACTURERS INSTRUCTIONS AND DETAILS TO ENSURE A NEAT WEATHER TIGHT ROOF.

ZINCALUME PARAPET CAPPING TO THE TOP OF ALL PARAPET WALLS.

COLORBOND PARAPET CAPPING TO MATCHED WALL COLOUR TO BE PROVIDED WITH A PLIABLE SARKING MEMBRANE AND EXTEND A MINIMUM OF 50mm DOWN EITHER SIDE OF THE PARAPET WITH A 5 DEGREE MIN SLOPE POSITIVE FALL BACK INTO BOX GUTTER / ROOF SHEETING. TYPICAL THROUGHOUT.

ALL EXTERNAL, EXPOSED FLASHINGS TO HAVE A ZINCALUME FINISH.

CO-ORDINATE INSTALLATION OF ROOF CLADDING WITH ALL SERVICES TO ALLOW FOR ANY PENETRATIONS.

EXTRA BRACING FOR SOLAR HOT WATER PANELS

SELECTED 'FIELDERS' OR EQUAL RAINWATER HEAD, GALVANISED FINISH.

DP 90/120mm ROUND PVC DOWNPIPE

120mm ROUND PVC DOWNPIPE WITH SPREADER END

COLORBOND ROOF SHEETING AT 22.5° ROOF PITCH. ARROW INDICATES DIRECTION OF FALL.

COLORBOND ROOF SHEETING AT 5° ROOF

PITCH. ARROW INDICATES DIRECTION OF FALL. COLORBOND ROOF SHEETING AT 1° ROOF


PITCH. ARROW INDICATES DIRECTION OF FALL.

BOX GUTTER SYSTEM IN ACCORDANCE WITH AS/NZS 3500.3 INCLUDING:

- MINIMUM BOX GUTTER 350MM X 90MM DEEP WITH 1:200 FALL
- MINIMUM SUMP SIZE 350W X 150D X 600L
- MINIMUM DOWNPIPE DIAMETER 90MM MINIMUM RAINHEAD SIZE 113DX110LX350W

	AMENDMENTO	-

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SHEET No.

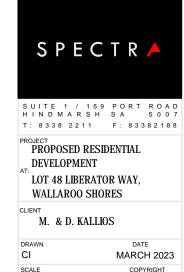WD 10 OF 24


AS SHOWN

16.2023

ROOF PLAN





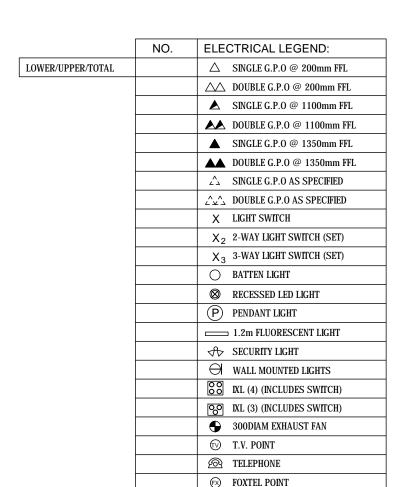

MS DENOTES MOTION SENSOR CONNECTED TO LIGHTS

CEILING FAN WITH LIGHT

CEILING FAN WITHOUT LIGHT

DA DATA POINT

WP DENOTES WATER PROOF EXTERNAL G.P.O

O DENOTES SMOKE DETECTOR HARD WIRED IN ACCORDANCE WITH AS 3786. SMOKE ALARMS TO BE INTERCONNECTED AS PER BCA PART 3.7.5.2(d) BCA-P2.3.2

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F	21.11.23	MINOR CHANGES	C.I.
G	31.01.24	CERTIFIER ISSUE	C.I.
Н	14.02.24	CERTIFIER RFI	C.I.



SUITE 1 / 159 PORT ROAD HINDMARSH SA 5007 T: 8338 2211 F: 83382188

PROJECT PROPOSED RESIDENTIAL DEVELOPMENT AT: LOT 48 LIBERATOR WAY, WALLAROO SHORES

CLIENT


DRAWN

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CI MARCH 2023
SCALE COPYRIGHT
AS SHOWN
PROJECT No. SHEET No.
16.2023 WD 11 OF 24





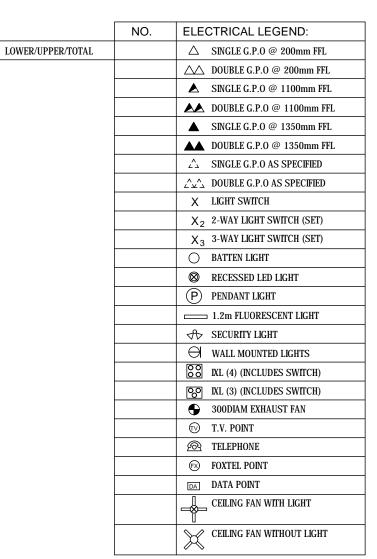

MS DENOTES MOTION SENSOR CONNECTED TO LIGHTS

WP DENOTES WATER PROOF EXTERNAL G.P.O

O DENOTES SMOKE DETECTOR HARD WIRED IN ACCORDANCE WITH AS 3786. SMOKE ALARMS TO BE INTERCONNECTED AS PER BCA PART 3.7.5.2(d) BCA-P2.3.2

Rev	Date	Description	Drawn
Α	14.03.23	PLANNING ISSUE	C.I.
В	24.03.23	DEKTON BLADE WALL	C.I.
С	24.04.23	ENCUMBRANCE RFI	C.I.
D	19.06.23	COUNCIL RFI	C.I.
Е	31.07.23	CONSULTANT ISSUE	C.I.
F	21.11.23	MINOR CHANGES	C.I.
G	31.01.24	CERTIFIER ISSUE	C.I.
Н	14.02.24	CERTIFIER RFI	C.I.



SUITE 1 / 159 PORT ROAD HINDMARSH SA 5007 T: 8338 2211 F: 83382188

PROJECT PROPOSED RESIDENTIAL DEVELOPMENT AT: LOT 48 LIBERATOR WAY, WALLAROO SHORES

CLIENT

M. & D. KALLIOS

 DRAWN
 DATE

 CI
 MARCH 2023

 SCALE
 COPYRIGHT

 AS SHOWN
 SHEET No.


 PROJECT No.
 SHEET No.

 16.2023
 WD 12 OF 24








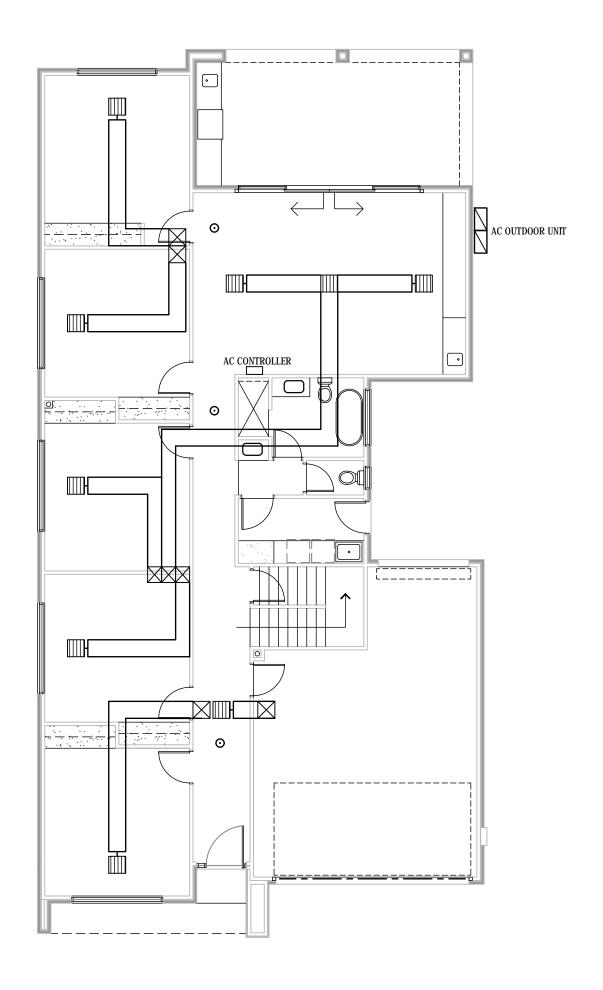


	AN	IENDMENTS	
Rev	Date	Description	Drawn
Α	14.03.23	PLANNING ISSUE	C.I.
В	24.03.23	DEKTON BLADE WALL	C.I.
С	24.04.23	ENCUMBRANCE RFI	C.I.
D	19.06.23	COUNCIL RFI	C.I.
Е	31.07.23	CONSULTANT ISSUE	C.I.
F	21.11.23	MINOR CHANGES	C.I.
G	31.01.24	CERTIFIER ISSUE	C.I.
Н	14.02.24	CERTIFIER RFI	C.I.

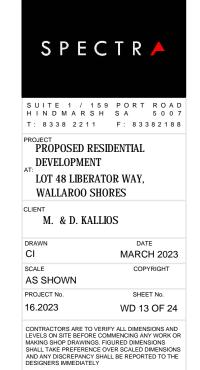









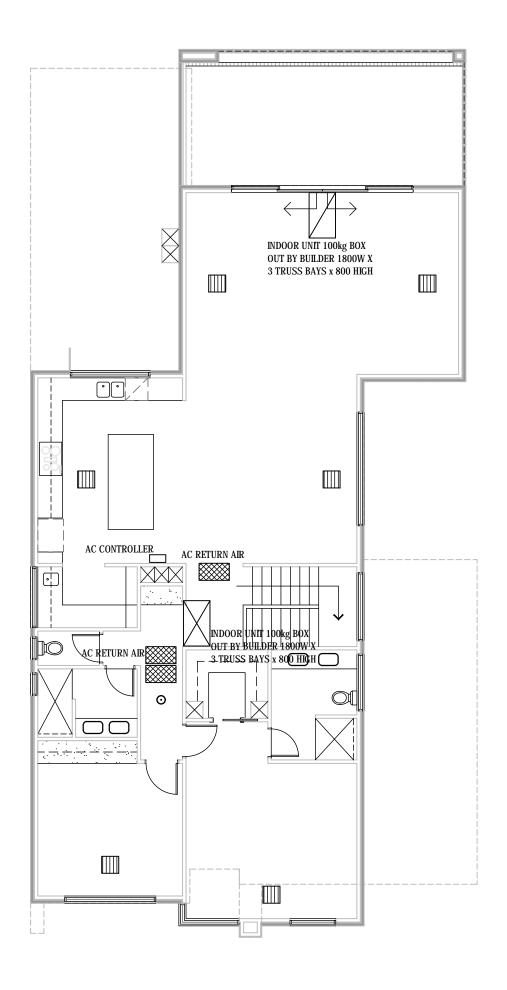


	AMENDMENTS			
Rev	Date	Description	Drawn	
Α	14.03.23	PLANNING ISSUE	C.I.	
В	24.03.23	DEKTON BLADE WALL	C.I.	
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D	19.06.23	COUNCIL RFI	C.I.	
Е	31.07.23	CONSULTANT ISSUE	C.I.	
F	21.11.23	MINOR CHANGES	C.I.	
G	31.01.24	CERTIFIER ISSUE	C.I.	
Н	14.02.24	CERTIFIER RFI	C.I.	

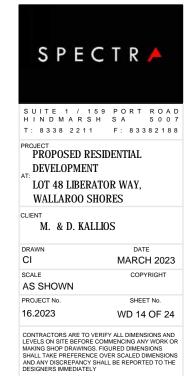



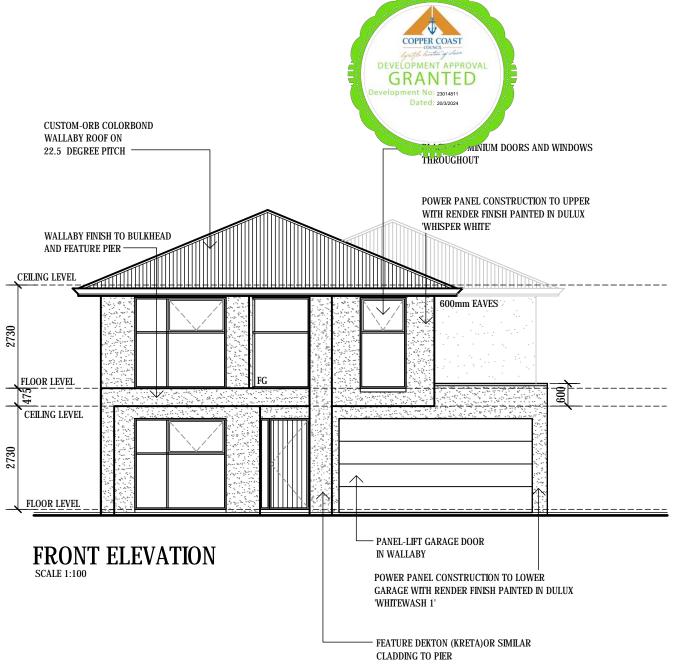

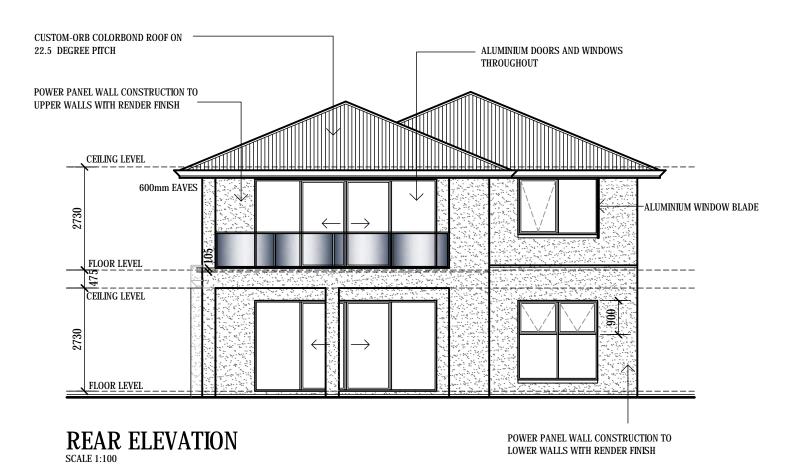

NOTE:

FOR OPERABLE WINDOWS WHERE THE FLOOR BELOW IS 2000mm OR MORE ABOVE THE SURFACE LEVEL AND WHERE THE LOWEST LEVEL OF THE WINDOW OPENING IS LESS THAN 1700mm ABOVE THE FLOOR THE WINDOW MUST BE PROTECTED WITH THE FOLLOWING:

- A DEVICE CAPABLE OF RESTRICTING WINDOW OPENING TO NOT PERMIT A 125mm SPHERE TO PASS THROUGH;
- A SCREEN WITH SECURE FITTINGS
 CAPABLE OF RESISTING A
 HORIZONTAL ACTION OF 250N
 AGAINST THE WINDOW RESTRAINED
 BY DEVICE OR SCREEN PROTECTING
 THE OPENING; AND

HAVE A CHILD RESISTANT RELEASE MECHANISM IF THE SCREEN OR DEVICE IS REMOVABLE, UNLOCKED OR OVERRIDDEN.

	AMENDMENTS			
Rev	Date	Description	Drawn	
Α	14.03.23	PLANNING ISSUE	C.I.	
В	24.03.23	DEKTON BLADE WALL	C.I.	
С	24.04.23	ENCUMBRANCE RFI	C.I.	
D	19.06.23	COUNCIL RFI	C.I.	
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G	31.01.24	CERTIFIER ISSUE	C.I.	
Н	14.02.24	CERTIFIER RFI	C.I.	



SUITE 1 / 159 PORT ROAD HINDMARSH SA 5007 T: 8338 2211 F: 83382188

PROJECT PROPOSED RESIDENTIAL DEVELOPMENT LOT 48 LIBERATOR WAY, WALLAROO SHORES


CLIENT

M. & D. KALLIOS

CI	MARCH 2023
AS SHOWN	COPYRIGHT
PROJECT No.	SHEET No.
16.2023	WD 15 OF 24





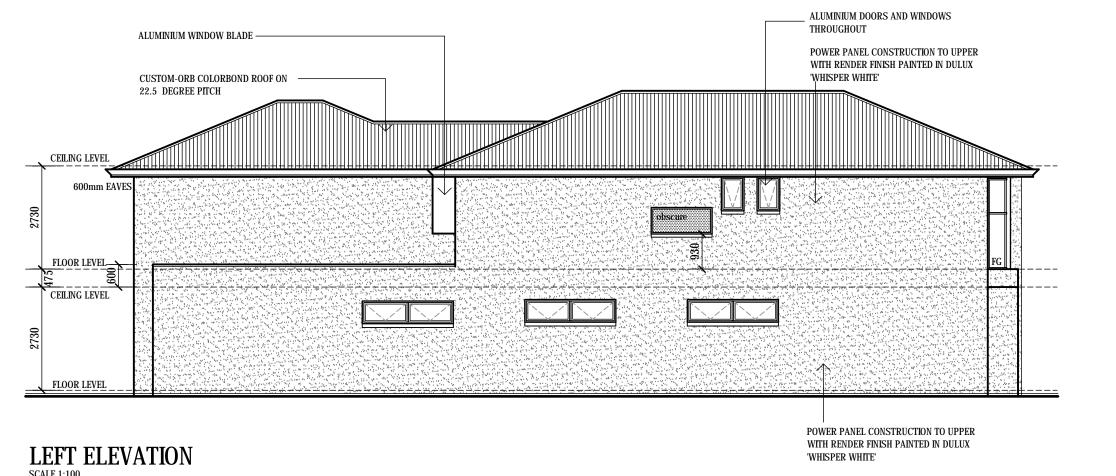

FOR OPERABLE WINDOWS WHERE THE FLOOR BELOW IS 2000mm OR MORE ABOVE THE SURFACE LEVEL AND WHERE THE LOWEST LEVEL OF THE WINDOW OPENING IS LESS THAN 1700mm ABOVE THE FLOOR THE WINDOW MUST BE PROTECTED WITH THE FOLLOWING:

- A DEVICE CAPABLE OF RESTRICTING WINDOW OPENING TO NOT PERMIT A 125mm SPHERE TO PASS THROUGH;
- A SCREEN WITH SECURE FITTINGS CAPABLE OF RESISTING A HORIZONTAL ACTION OF 250N AGAINST THE WINDOW RESTRAINED BY DEVICE OR SCREEN PROTECTING

THE OPENING; AND HAVE A CHILD RESISTANT RELEASE MECHANISM IF THE SCREEN OR DEVICE IS REMOVABLE, UNLOCKED OR OVERRIDDEN.

	AMENDMENTS			
Rev	Date	Description	Drawn	
Α	14.03.23	PLANNING ISSUE	C.I.	
В	24.03.23	DEKTON BLADE WALL	C.I.	
С	24.04.23	ENCUMBRANCE RFI	C.I.	
D	19.06.23	COUNCIL RFI	C.I.	
Е	31.07.23	CONSULTANT ISSUE	C.I.	
F	21.11.23	MINOR CHANGES	C.I.	
		CERTIFIER ISSUE	C.I.	
Н	14.02.24	CERTIFIER RFI	C.I.	



SUITE 1 / 159 PORT ROAD HINDMARSH SA 5007 T: 8338 2211 F: 83382188

PROPOSED RESIDENTIAL DEVELOPMENT LOT 48 LIBERATOR WAY,


WALLAROO SHORES

M. & D. KALLIOS

DRAWN	DATE
CI	MARCH 2023
SCALE	COPYRIGHT
AS SHOWN	
PROJECT No.	SHEET No.
16.2023	WD 16 OF 24





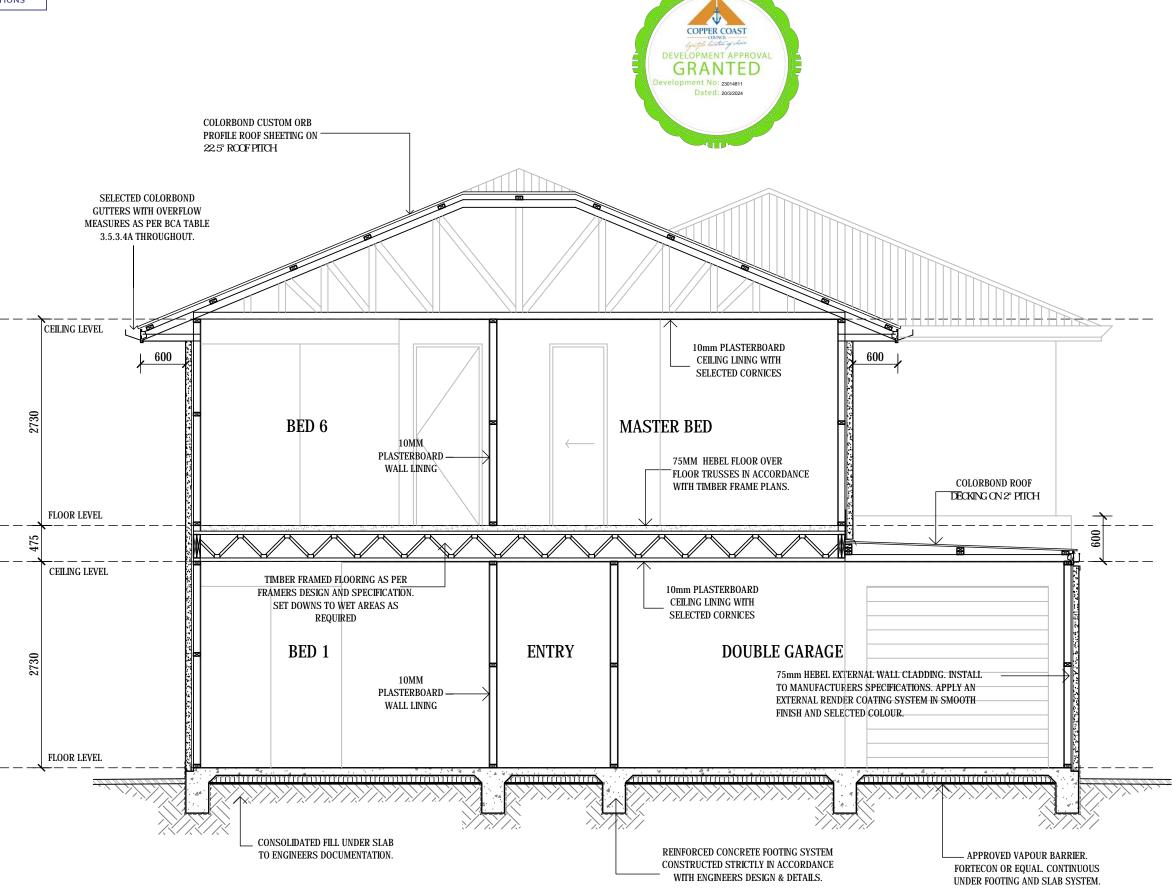

SECTION AA

SCALE 1:50

-				
Α	14.0	3.23	PLANNING ISSUE	C.I.
В	24.0	3.23	DEKTON BLADE WALL	C.I.
С	24.0	4.23	ENCUMBRANCE RFI	C.I.
D	19.0	6.23	COUNCIL RFI	C.I.
Е	31.0	7.23	CONSULTANT ISSUE	C.I.
F	21.1	1.23	MINOR CHANGES	C.I.
G	31.0	1.24	CERTIFIER ISSUE	C.I.
Н	14.0	2.24	CERTIFIER RFI	C.I.

AMENDMENTS
Rev Date Description



PROJECT
PROPOSED RESIDENTIAL
DEVELOPMENT
LOT 48 LIBERATOR WAY,
WALLAROO SHORES

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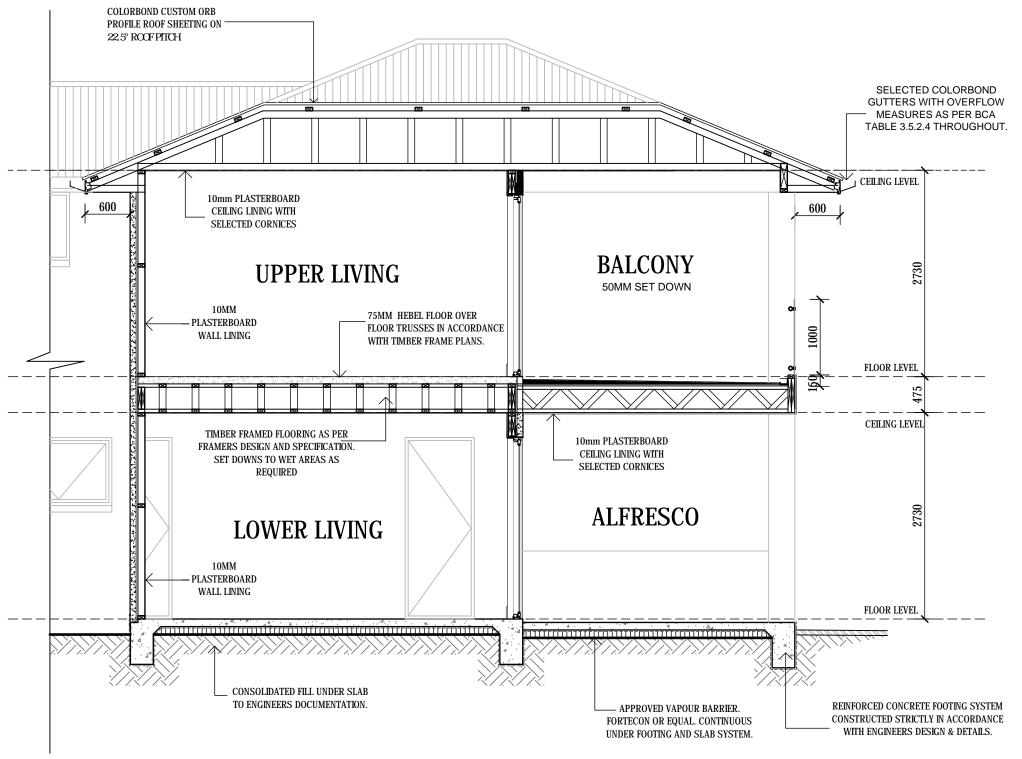
M. & D. KALLIOS

CI	MARCH 2023
SCALE AS SHOWN	COPYRIGHT
PROJECT No.	SHEET No.
16.2023	WD 17 OF 24











SCALE 1:50

Rev	Date	Description	Drawn
Α	14.03.23	PLANNING ISSUE	C.I.
В	24.03.23	DEKTON BLADE WALL	C.I.
С	24.04.23	ENCUMBRANCE RFI	C.I.
D	19.06.23	COUNCIL RFI	C.I.
Ε	31.07.23	CONSULTANT ISSUE	C.I.
F	21.11.23	MINOR CHANGES	C.I.
G	31.01.24	CERTIFIER ISSUE	C.I.
Н	14.02.24	CERTIFIER RFI	C.I.



S U I T E 1 / 159 P O R T R O A D H I N D M A R S H S A 5 0 0 7 T: 8338 2211 F: 83382188


PROJECT
PROPOSED RESIDENTIAL
DEVELOPMENT
AT.
LOT 48 LIBERATOR WAY,

CLIENT

M. & D. KALLIOS


WALLAROO SHORES

CI	MARCH 2023		
AS SHOWN	COPYRIGHT		
PROJECT No.	SHEET No.		
16.2023	WD 18 OF 24		

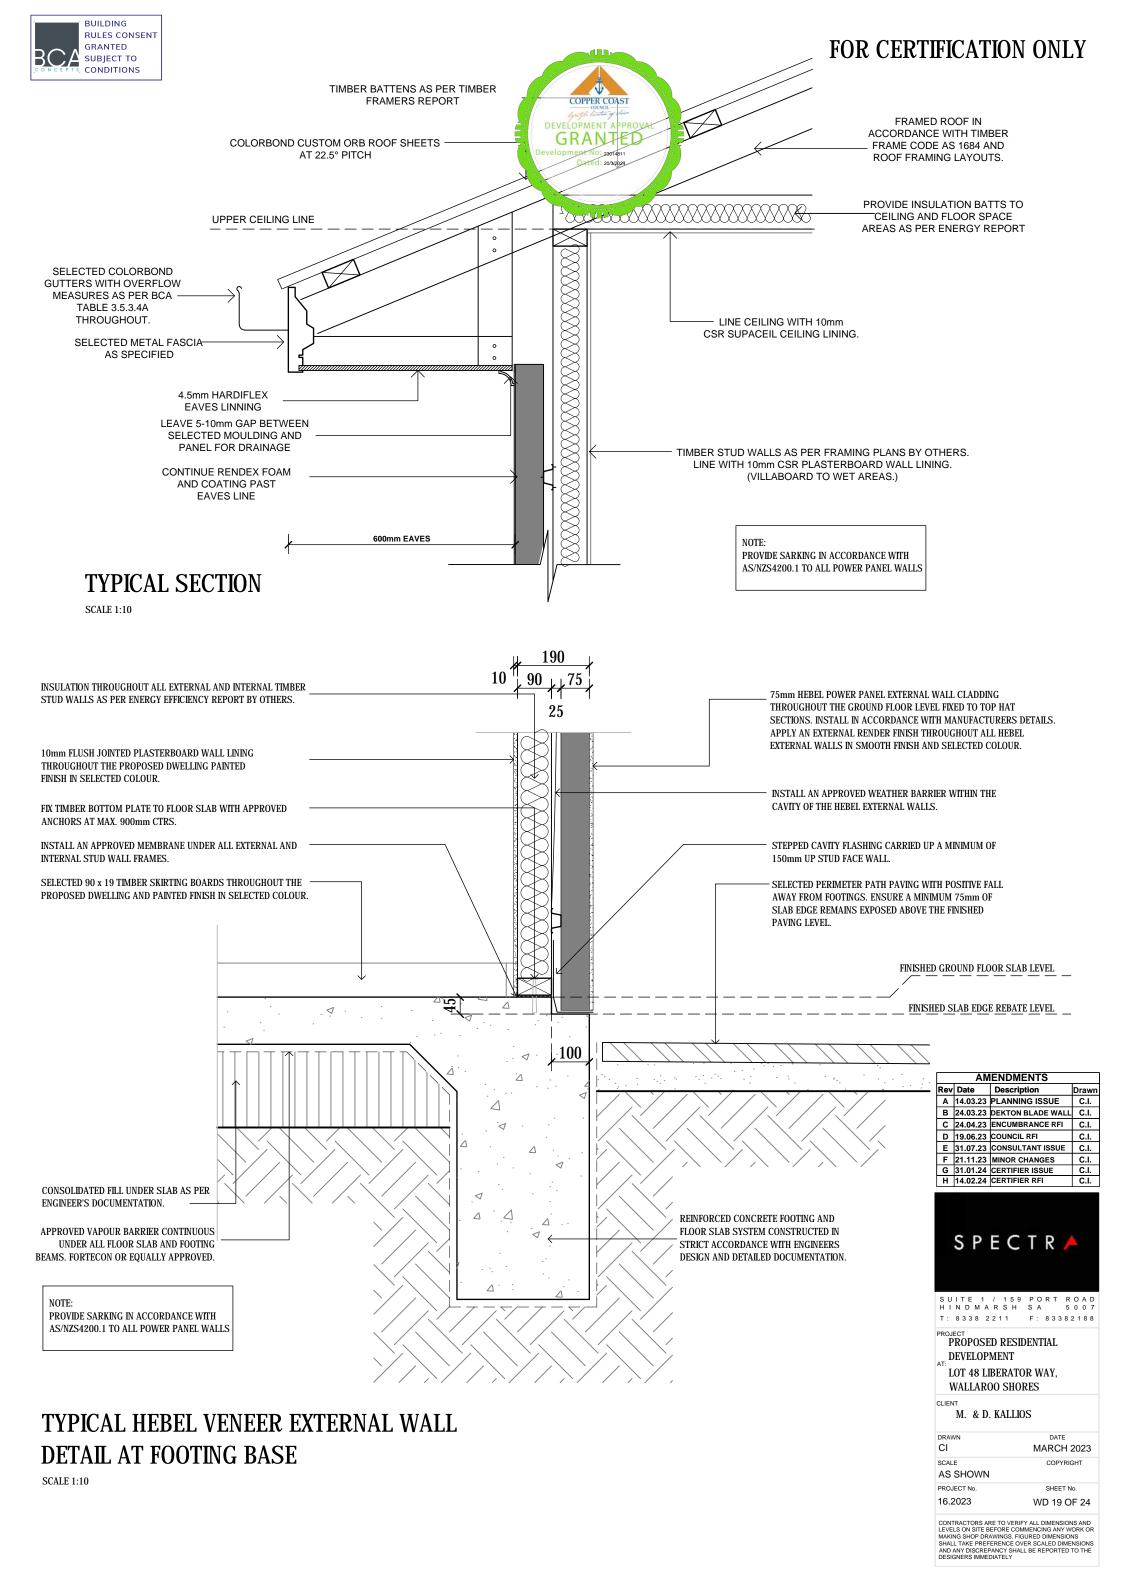






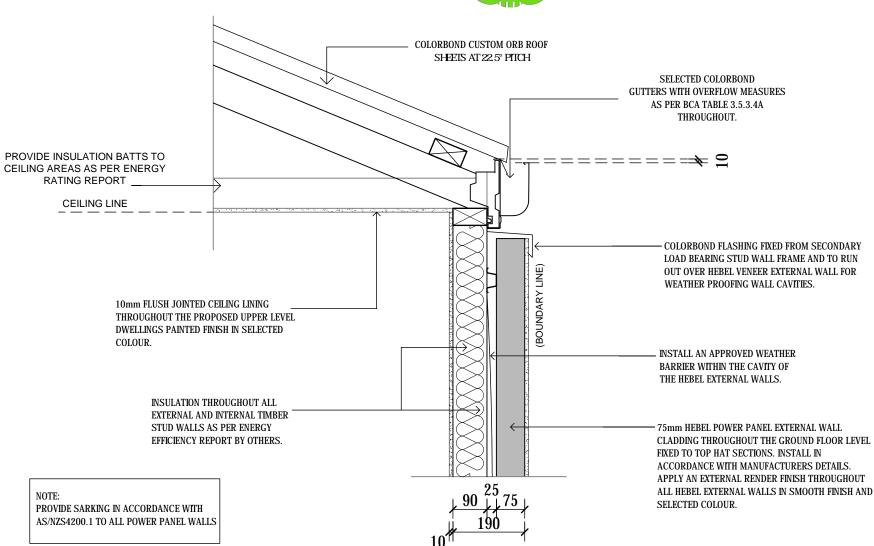


BOUNDARY GUTTER DETAIL


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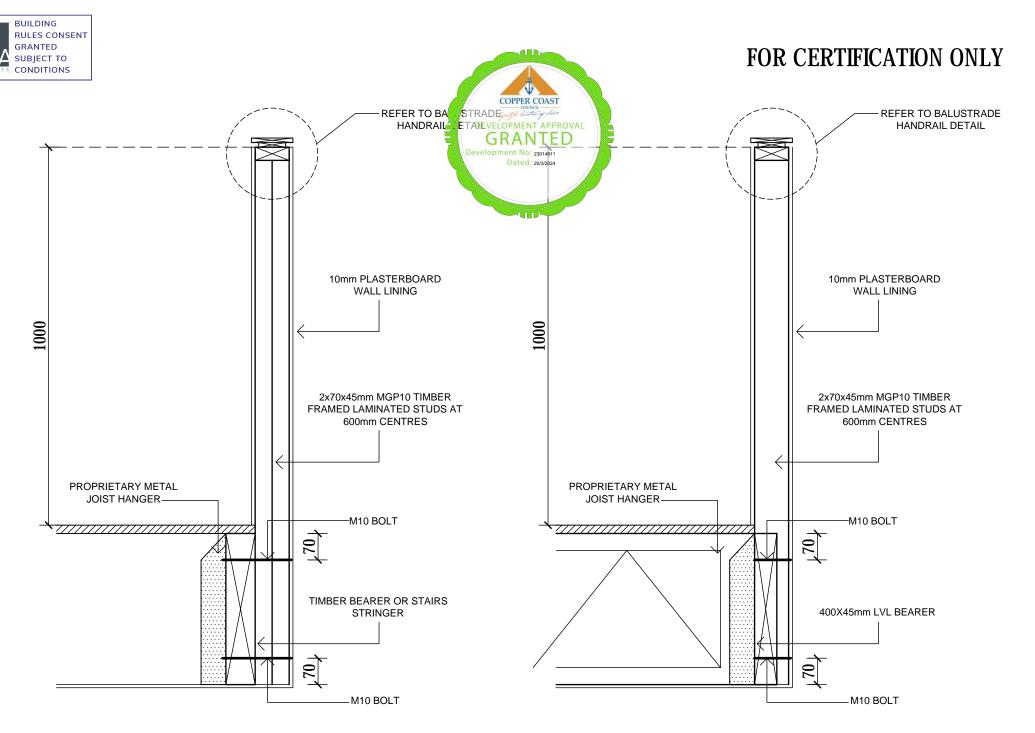


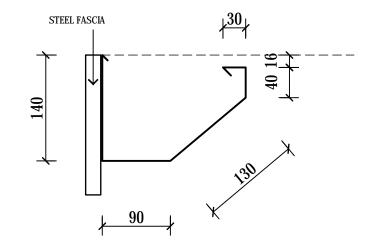TYPICAL GUTTER DETAIL

SCALE 1: 5




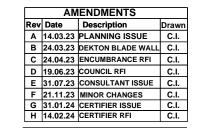

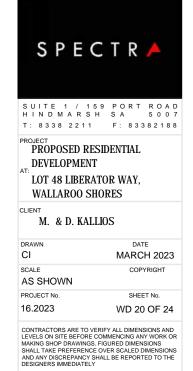


INTERNAL BALUSTRADE SECTION DETAIL

SCALE 1:10

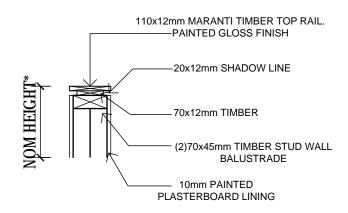

BALUSTRADE SECTION DETAIL


SCALE 1:10

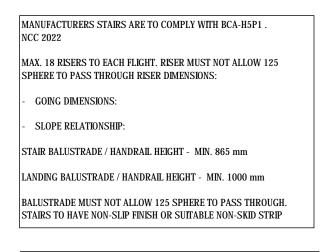

NOTE:

TREADS TO HAVE SURFACE OR NOSING STRIP WITH A SLIP-RESISTANCE CLASSIFICATION NOT LESS THAN THAT LISTED IN TABLE 11.2.4 WHEN TESTED IN ACCORDANCE WITH AS $4586\,$

NOTE: STAIRS AND BALUSTRADES TO BE CONSTRUCTED IN ACCORDANCE WITH CERTIFIED MANUFACTURERS SYSTEM

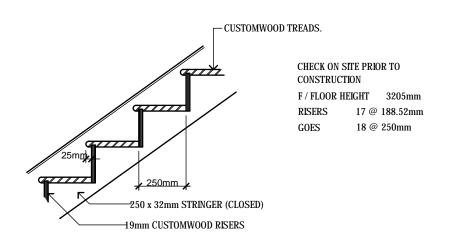

TYPICAL STAIR DETAIL

SCALE 1:20

		1 22	ENC	UMB				
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PROJE P: D: AT: L: W CLIEN	EVE EVE OT 4 VALI T M.	8 2 OSE LOP 8 LI AR(ED R MEN BER DO S	ESII VT CATO SHO	DENTO DR W RES	83 FIAL /AY,	3 8 2	2 1 8 8
PROJE P. D. AT: LI W. CLIEN	ROP EVE OT 4 /ALI T M.	8 2 OSE LOP 8 LI AR(ED R MEN BER DO S	ESII VT CATO SHO	DENTO DR W RES	8 3 TIAL /AY,	те СН 2	2 1 8 8
PROJE P: D AT: L(W CLIEN' DRAW CI SCALE	ROP EVE OT 4 /ALI T M.	8 2 OSE LOP 8 LI .ARC	ED R MEN BER DO S	ESII VT CATO SHO	DENTO DR W RES	8 3 TIAL /AY,	3 8 2	2 1 8 8
PROJE P: D AT: L(W CLIEN' DRAW CI SCALE	ROP EVEL OT 4 /ALI T M.	8 2 OSE LOP: 8 LI .ARC	ED R MEN BER DO S	ESII VT CATO SHO	DENTO DR W RES	B 3 FIAL /AY, DA ARC	те СН 2	2023 ЭНТ
PROJE P: D AT: LI W CLIEN' DRAW CI SCALE AS:	ECT ROP EVE OT 4 /ALI T M.	8 2 OSE LOP: 8 LI .ARC	ED R MEN BER DO S	ESII VT CATO SHO	DENT DR W RES DS	DA ARC COF	TE CH 2	2023 ЭНТ

AMENDMENTS

Rev Date Description


A 14.03.23 PLANNING ISSUE

B 24.03.23 DEKTON BLADE WALL C.I.

C.I.





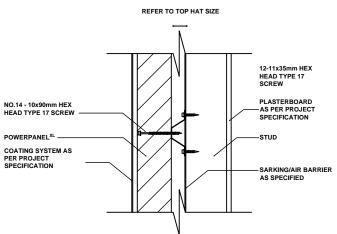

COPPER COAST REFER TO TOP HAT SIZE DEVELOPMENT APPROVAL GRANTED nt No: 23014811 Dated: 20/3/2024 HEBEL DIRECT FIX CLIP PLASTERBOARD AS PER PROJECT SPECIFICATION 0 12-11 x 35mm HEX HEAD TYPE 17 HEBEL POWERPANELXL PANE 0 TIMBER OS STEEL

HEBEL POWERPANEL^{XL} EXTERNAL WALL SYSTEM FIXING DETAIL HEBEL POWERPANEL^{XL} DUAL ZERO BOUNDARY WALLS FIXING (ACHIEVES FRL 90/90/90 WHEN INSTALLED AS PART OF THE WALL DETAIL (ACHIEVES FRL 90/90/90 WHEN INSTALLED AS PART OF SYSTEM. SEE SECTION 2.2 OF HEBEL POWERPANEL^{XL} EXTERNAL THE WALL SYSTEM. SEE SECTION 2.2 OF HEBEL POWERPANEL^{XL} EXTERNAL WALLS DESIGN AND INSTALLATION

SCALE 1:5

NOTE:
WHEN POSITIONING THE STUD FRAMES ALLOW 5-7mm EXTRA CAVITY WIDTH FOR THE SHEET BRACING BETWEEN TOP HAT AND TIMBER STUD.

WALLS DESIGN AND INSTALLATION GUIDE)


IMPORTANT: TOP HAT CLIP IS FIXED ON THE LEFT HAND SIDE OF THE STUD (WHEN LOOKING FROM INSID OF THE BUILDING) EXCEPT AT THE LAST STUD, ONLY, WHEN THE CLIP MAY BE INSTALLED UPSIDE DOWN

INSTALLING THE CLIP UPSIDE DOWN I.e WHERE THE SCREW FIXING FROM THE CLIP TO THE TOP HAT IS AT THE BOTTOM FLANGE OF THE TOP HAT, WILL BE ACCEPTABLE PROVIDED THAT:


- A: THE UPSIDE DOWN CLIP IS FIXED ON THE RIGHT HAND SIDE OF THE STUD (WHEN LOOKING FROM THE INSIDE TO THE OUTSIDE OF THE BUILDING)
 THE UPSIDE DOWN CLIP INSTALLATION IS TO THE LAST STUD OFA WALL RUN (ONLY), SUCH THAT THE SPACING
 BETWEEN THE LAST AND SECOND LAST STUDS IS NO GREATER THAN 600mm,
 THE TOP HAT IS CONTINUOUS IN THIS REGION FOR A MINIMUM OF TWO SPANS I.E TOP HAT EXTENDS ACROSS TWO
- STUD SPACINGS,
 D: IN ALL OTHER LOCATIONS, CLIPS ARE TO BE INSTALLED TO THE LEFT HAND SIDE OF THE STUD WITH THE SCREW FIXING TO THE TOP SIDE OF THE CLIP i.e INTO THE TOP FLANGE OF THE HORIZONTAL TOP HAT.

OUTSIDE BUILDING R = RIGHT SIDE OF STUD


HEBEL POWERPANELXL **FIXING & INSTALLATION DETAILS**

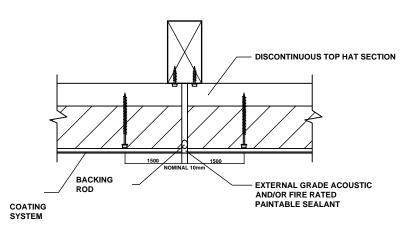


TYPICAL VERTICAL CONTROL JOINT (ACHIEVES FRL -/120/120 WHEN INSTALLED AS PART OF THE WALL SYSTEM.

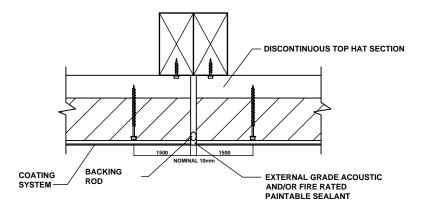

TYPICAL VERTICAL CONTROL JOINT (DISCONTINUOUS TOP HAT ON A **DOUBLE STUD)** (ACHIEVES FRL -/120/120 WHEN INSTALLED AS PART OF THE WALL SYSTEM.

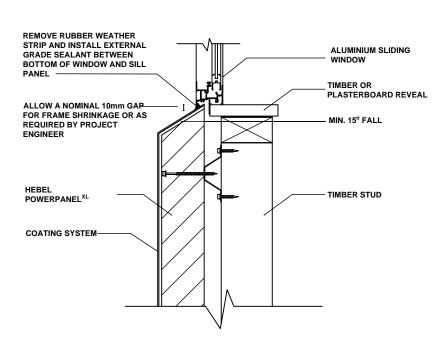


TYPICAL WINDOW SILL **DETAIL**

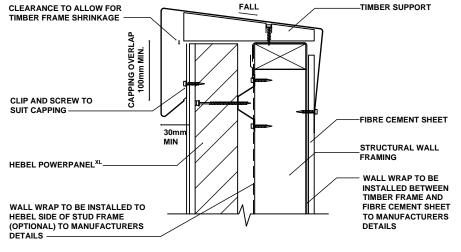

PARAPET CAPPING

PARAPET CAPPING SHALL BE DESIGNED AND EASTENED IN ACCORDANCE WITH SAA - HB39 2015 - INSTALLATION CODE FOR METAL ROOFING AND WALL CLADDING. STOP ENDS SHALL BE INCORPORATED TO ALL FLASHINGS.

	AMENDMENTS				
Rev	Date	Description	Drawn		
Α	14.03.23	PLANNING ISSUE	C.I.		
В	24.03.23	DEKTON BLADE WALL	C.I.		
С	24.04.23	ENCUMBRANCE RFI	C.I.		
D	19.06.23	COUNCIL RFI	C.I.		
Е	31.07.23	CONSULTANT ISSUE	C.I.		
F	21.11.23	MINOR CHANGES	C.I.		
G	31.01.24	CERTIFIER ISSUE	C.I.		
Н	14.02.24	CERTIFIER RFI	C.I.		

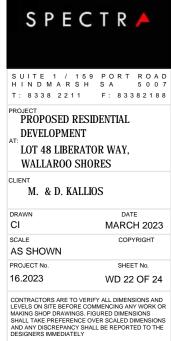





DETAILS SCALE AS SPECIFIED

SHOWER ENCLOSURE.

MPERVIOUS SURFACE.

TOP OF TRAY SIDE.

MORTAR BED.

FLEXBLE SEALANT 3 - 5mm WIDE.

WATER RESISTANT LINING.


WATER RESISTANT LINING.


WET AREA NOTES:

SET DOWN WET AREAS 45mm.
SCREED WITH REQUIRED FALL TO
FLOOR TRAP
THE FLOOR OF A WET AREA
CONTAINING A VESSEL MUST BE
GRADED TO FLOOR WASTE UNLESS
ALL VESSELS ARE PROVIDED WITH

IN-BUILT OVERFLOW PROTECTION OR HAVE PERMANENT OPEN TRAPPED CONNECTION TO THE PLUMBING IN ACCORDANCE WITH SA 10.2.33.


HOB AT SHOWER TRAY

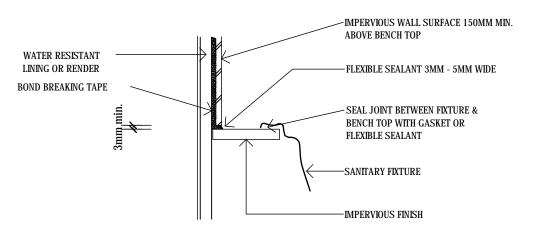

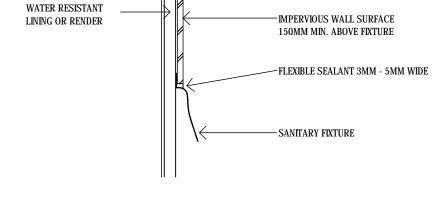

IMPERVIOUS JUNCTION OF FIXTURE & IMPERVIOUS WALL

IMPERVIOUS JUNCTION OF FIXTURE & IMPERVIOUS WALL

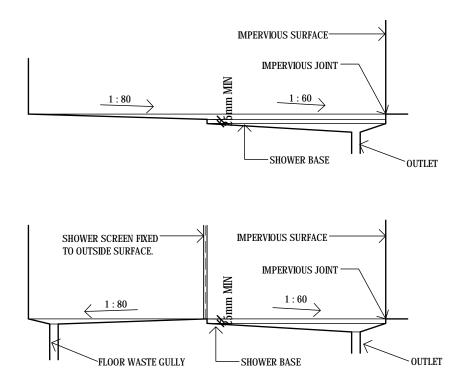

SHOWER BASE SETDOWNS & FLOOR GRADIENTS

_	27.07.23	LITOOMBITAIT	OL 1111	0.1.
D	19.06.23	COUNCIL RFI		C.I.
Е	31.07.23	CONSULTAN	TISSUE	C.I.
F	21.11.23	MINOR CHAN	IGES	C.I.
G	31.01.24	CERTIFIER IS	SUE	C.I.
Н	14.02.24	CERTIFIER RI	FI	C.I.
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SCAL	E SHOWN		COPYRI	GHT
PRO	JECT No.		SHEET N	No.


CONTRACTORS ARE TO VERIFY ALL DIMENSIONS AND LEVELS ON SITE BEFORE COMMENCING ANY WORK OR MAKING SHOOP DRAWINGS, FIGURED DIMENSIONS SHALL TAKE PREFERENCE OVER SCALED DIMENSIONS AND ANY DISCREPANCY SHALL BE REPORTED TO THE DESIGNERS IMMEDIATELY


WD 23 OF 24

16.2023

AMENDMENTS
Rev Date Description
A 14.03.23 PLANNING ISSUE


B 24.03.23 DEKTON BLADE WALL C.I.
C 24.04.23 ENCUMBRANCE RFI C.I.

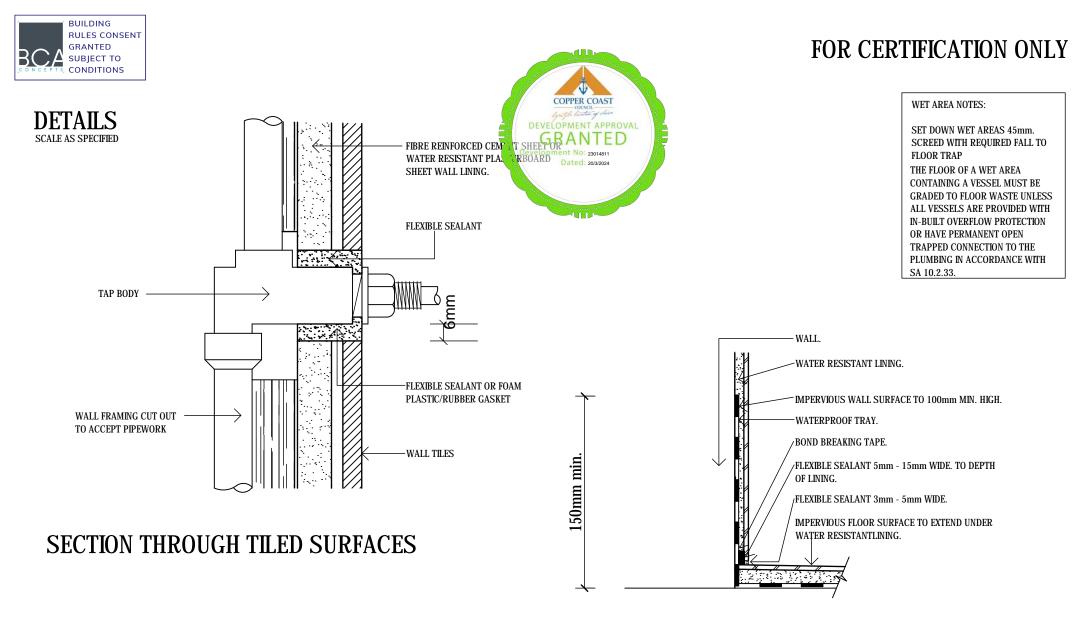

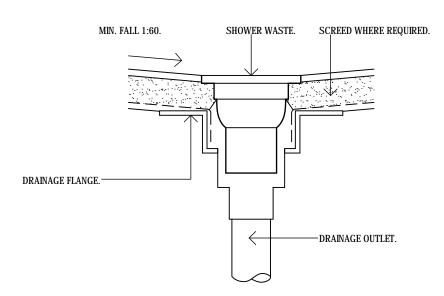

JUNCTION OF IMPERVIOUS WALL AND IMPERVIOUS FLOOR

DETAILS OF FLOOR / SHOWER TRAP

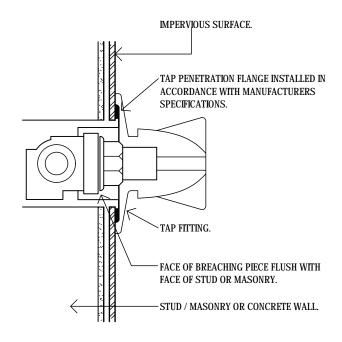

PENETRATIONS THROUGH WALLS IN SHOWER AREA.

Rev	Date	Description	Drawn
Α	14.03.23	PLANNING ISSUE	C.I.
В	24.03.23	DEKTON BLADE WALL	C.I.
С	24.04.23	ENCUMBRANCE RFI	C.I.
D	19.06.23	COUNCIL RFI	C.I.
Е	31.07.23	CONSULTANT ISSUE	C.I.
F	21.11.23	MINOR CHANGES	C.I.
G	31.01.24	CERTIFIER ISSUE	C.I.
Н	14.02.24	CERTIFIER RFI	C.I.

AMENDMENTO

